


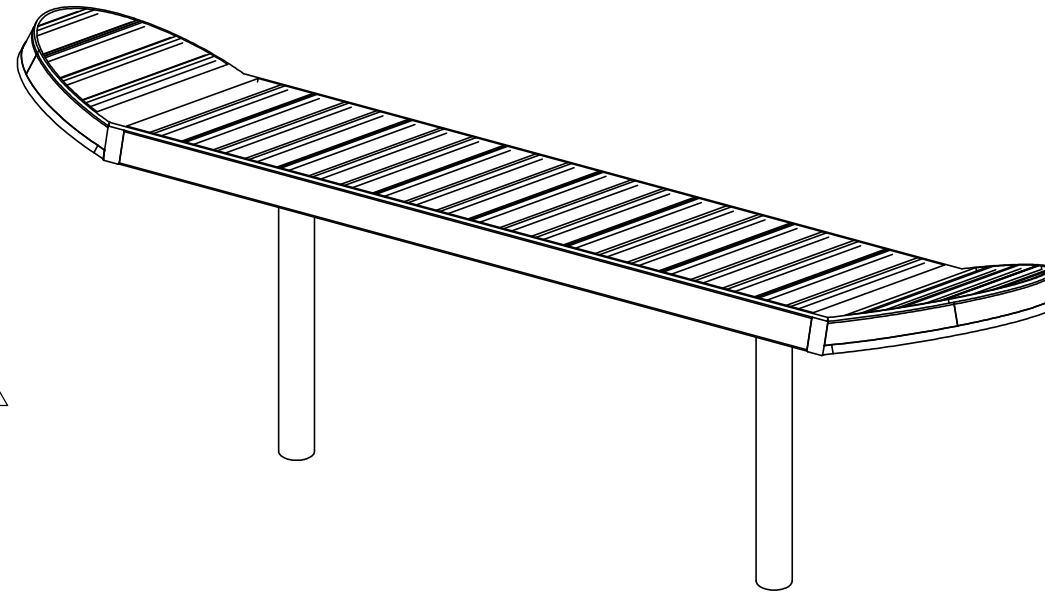

REVISIONS			
REV.	DESCRIPTION	BY	DATE
A	ADD MARQUEE-LOK SOFFIT	ML	9/27/2023

PROJECT: COLLEGE PARK  
 LOCATION: LOMOC, CA  
 BUILDING TYPE: WALKWAY 8X31  
 ROOF TYPE: MULTI-RIB OVER T & G W/ 22 GA MARQUEE-LOK SOFFIT <sup>△</sup>  
 BUILDING NUMBER: P17604  
 ORDER NUMBER: 76959  
 QUOTE NUMBER: 8846R1



**DRAWING LIST:**

SHEET NUMBER	DRAWING DESCRIPTION
CS	COVER SHEET
1	ARCHITECTURAL ELEVATIONS
2	STRUCTURAL FRAMING PLAN
3	COLUMN LAYOUT

**CERTIFICATES:**  
 MIAMI-DADE COUNTY CERTIFICATE OF COMPETENCY NO. 21-0819.13  
 PCI (POWDER COATING INSTITUTE) 4000 CERTIFIED

**FABRICATOR APPROVALS:**  
 CITY OF PHOENIX, AZ APPROVED FABRICATOR #C08-2010  
 CITY OF LOS ANGELES, CA APPROVED FABRICATOR #FB01596  
 CITY OF RIVERSIDE, CA APPROVED FABRICATOR #SF\_000042  
 CITY OF HOUSTON, TX APPROVED FABRICATOR #470  
 CLARK COUNTY, NV APPROVED FABRICATOR #264  
 STATE OF UTAH APPROVED FABRICATOR 02008-14  
 AISC APPROVED FABRICATOR C-00018751

MATERIALS:	DESCRIPTION	ASTM DESIGNATION
	TUBE STEEL	A500 (GRADE B)
	SCHEDULE PIPE	A53 (GRADE B)
	RMT PIPE	A519
	LIGHT GAGE COLD FORMED	A1003 (GRADE 50)
	STRUCTURAL STEEL PLATE	A36
	ROOF PANELS (STEEL)	A653



**GENERAL NOTES:**  
 UNLESS NOTED OTHERWISE, THIS STRUCTURE WAS DESIGNED TO ONLY SUPPORT WHAT IS SHOWN ON THESE DRAWINGS. THE MANUFACTURER MUST BE CONTACTED IF ANYTHING ELSE IS TO BE ATTACHED TO THIS STRUCTURE (WALLS, COLUMN WRAPS, RAILINGS, ETC.) SO THE DESIGN OF THIS STRUCTURE CAN BE REVIEWED AND POSSIBLY REVISED.

UNLESS NOTED OTHERWISE, THIS STRUCTURE WAS DESIGNED ASSUMING A 20' SEPARATION BETWEEN ANY ADJACENT STRUCTURE WITH AN EAVE HEIGHT EQUAL TO OR GREATER THAN THE EAVE HEIGHT OF THIS STRUCTURE. IF THAT SEPARATION DOES NOT EXIST, THE MANUFACTURER MUST BE CONTACTED SO THE DESIGN OF THIS STRUCTURE CAN BE REVIEWED AND POSSIBLY REVISED.

STRUCTURAL STEEL SHALL BE DETAILED, FABRICATED, AND ERECTED IN ACCORDANCE WITH THE LATEST EDITION OF THE AMERICAN INSTITUTE OF STEEL CONSTRUCTION (AISC) SPECIFICATION MANUAL.

ALL WELDING IS PERFORMED BY AMERICAN WELDING SOCIETY (AWS) CERTIFIED WELDERS AND CONFORMS TO THE LATEST EDITION OF AWS D1.1 OR D1.3 AS REQUIRED.

PARTS SHOWN MAY BE UPGRADED DUE TO STANDARDIZED FABRICATION. REFER TO THE SHIPPING BILL OF MATERIALS FOR POSSIBLE SUBSTITUTIONS.

FOR PROPER FIELD INSTALLATION OF THE BUILDING IT IS RECOMMENDED THAT THE PRIMARY FRAME INSTALLER AND THE ROOF INSTALLER HAVE A MINIMUM FIVE (5) YEARS DOCUMENTED EXPERIENCE INSTALLING THIS TYPE OF PRODUCT.


FOR PROPER FIELD INSTALLATION OF THE BUILDING IT IS RECOMMENDED THAT ELECTRIC WIRING, IF REQUIRED, BE RUN THROUGH THE STRUCTURAL MEMBERS BEFORE THE BUILDING IS ERECTED.

**STOP!!**  
**NOT FOR CONSTRUCTION**  
 USE FOR PRELIMINARY  
 PLANNING AND ESTIMATING  
 ONLY


**poligon**  
 by PORTER CORP  
 WWW.POLIGON.COM  
 MAIN: (616) 888-3500  
 FIELD SUPPORT: (616) 888-3504

REV LEVEL: A  
 SCALE: 1:64  
 DRAWN BY: michael.leitch  
 PRINT DATE: 9/27/2023  
 JOB NO: P17604  
 CAD MODEL: ~P17604


PROJECT: COLLEGE PARK  
 PROJECT LOCATION: LOMOC, CA  
 DRAWING: COVER SHEET  
 SHEET

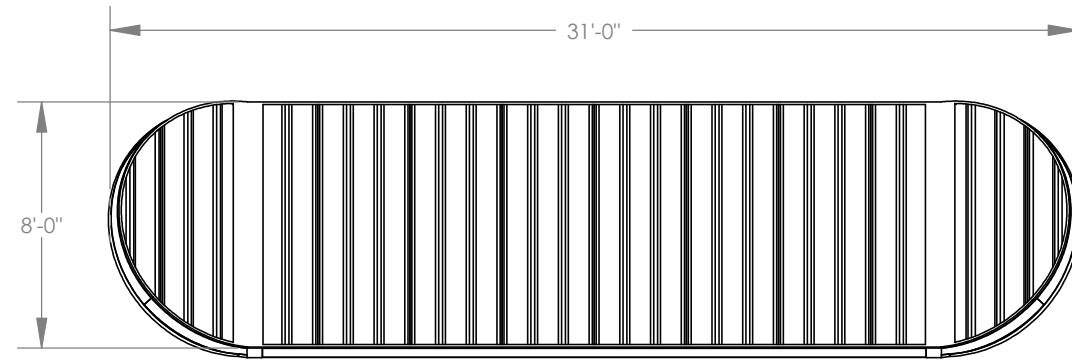

TOP VIEW

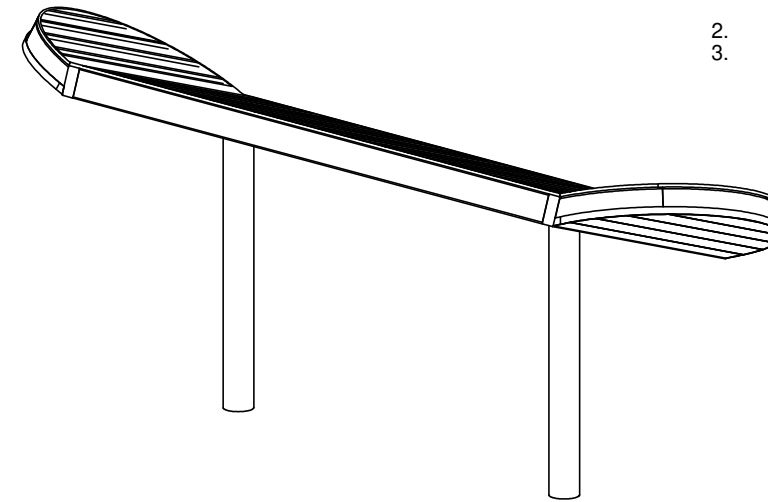


ISOMETRIC VIEW

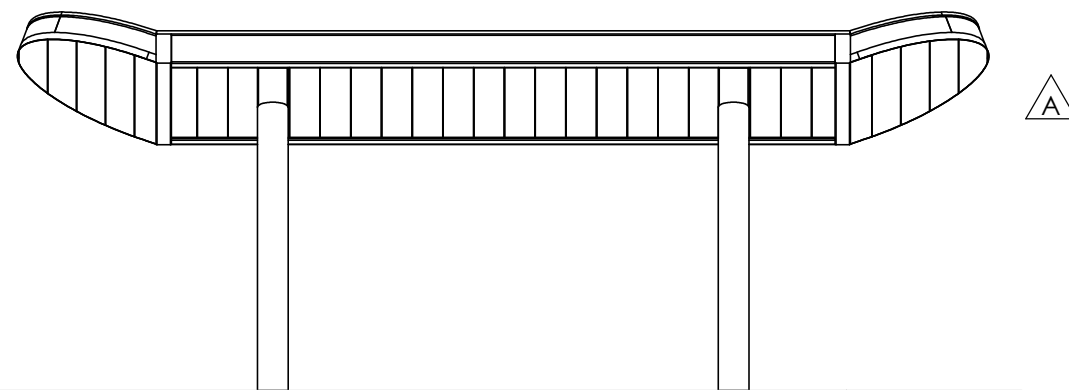

FRONT VIEW

FINISH GRADE  
(ASSUMED AT CONSTANT  
ELEVATION UNLESS  
OTHERWISE NOTED)

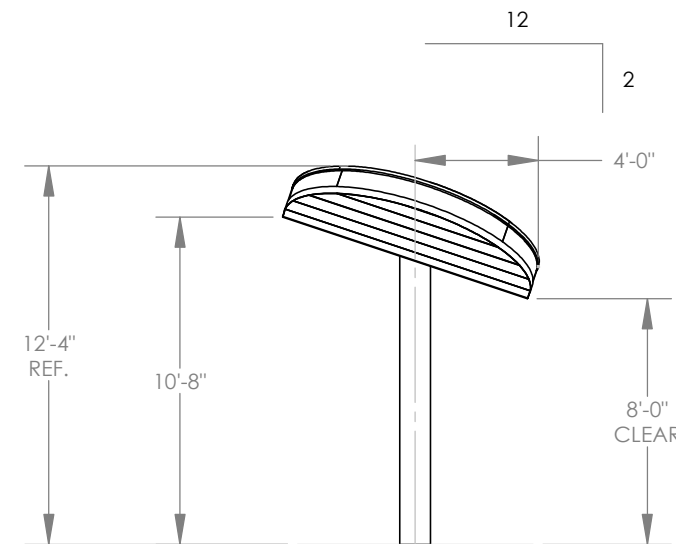

SIDE VIEW

**GENERAL ROOF NOTES:**


1. METAL ROOFING:
  - 24 GAUGE
  - GALVALUME COATED
  - KYNAR 500 PAINTED
2. TRIM COLOR MATCHES ROOF
3. SEE POLIGON.COM FOR COLOR OPTIONS

**STOP!!**  
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USE FOR PRELIMINARY  
PLANNING AND ESTIMATING  
ONLY


REV LEVEL:	A
SCALE:	1:75
DRAWN BY:	michael.leitch
PRINT DATE:	9/27/2023
JOB NO.:	P17604
CAD MODEL:	~P17604

PROJECT:	COLLEGE PARK
PROJECT LOCATION:	LOMOC, CA
DRAWING:	ARCHITECTURAL ELEVATIONS


SHEET

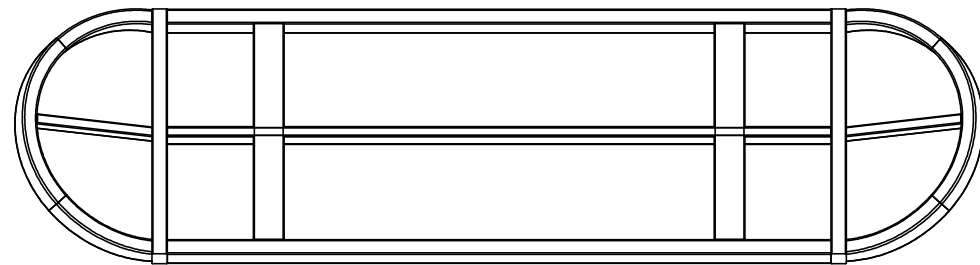

TOP VIEW

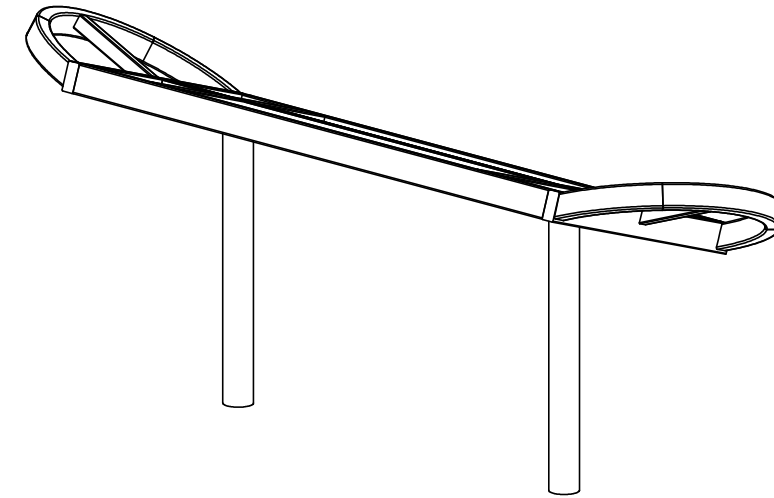


ISOMETRIC VIEW

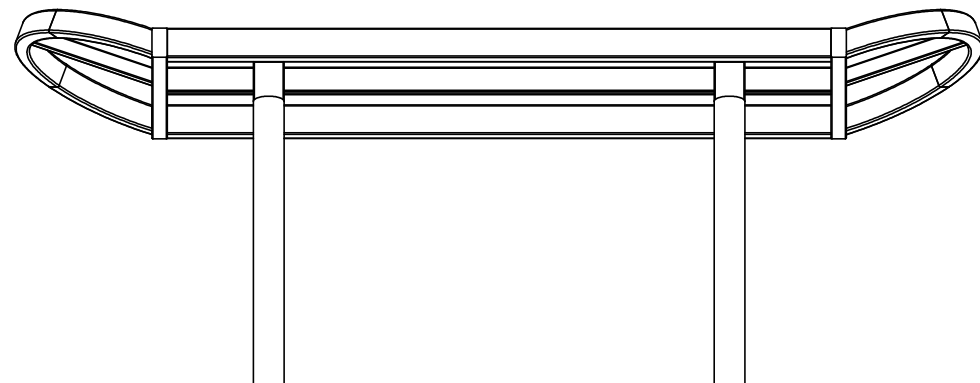

FRONT VIEW

FINISH GRADE  
(ASSUMED AT CONSTANT  
ELEVATION UNLESS  
OTHERWISE NOTED)

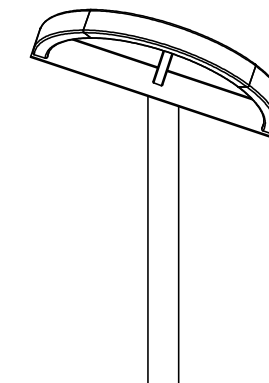

SIDE VIEW

**STOP!!**  
**NOT FOR CONSTRUCTION**

USE FOR PRELIMINARY  
PLANNING AND ESTIMATING  
ONLY

REV LEVEL:

A

DRAWN BY:  
michael.leitch

PRINT DATE:  
9/27/2023

JOB NO:  
P17604

CAD MODEL:  
~P17604

SCALE:  
1:75

PROJECT:  
COLLEGE PARK

PROJECT LOCATION:  
LOMOC, CA


DRAWING:  
STRUCTURAL FRAMING PLAN

SHEET

**2**

**STOP!!**  
NOT FOR CONSTRUCTION

USE FOR PRELIMINARY  
PLANNING AND ESTIMATING  
ONLY

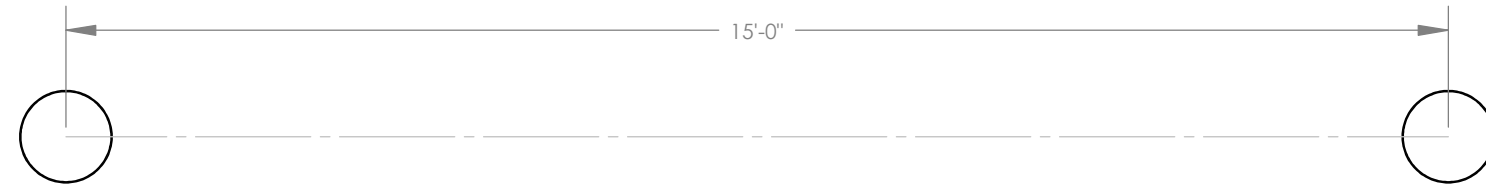

**ANCHOR BOLT LAYOUT NOTES:**

1. ENGINEERING WILL DETERMINE REQUIRED ANCHOR BOLT LAYOUT AFTER ENGINEERING PACKAGE IS ORDERED.
2. CUSTOMER MAY SUGGEST PREFERRED ANCHOR BOLT LAYOUT.

PROJECT:	COLLEGE PARK	PRINT DATE:	9/27/2023	DRAWN BY:	michael.leitch	REV LEVEL:	A
PROJECT LOCATION:	LOMOC, CA	JOB NO.:	P17604			SCALE:	1:25
DRAWING:	COLUMN LAYOUT	CAD MODEL:	~P17604				
SHEET	<b>3</b>						
				<b>poligon</b> <sup>®</sup>		WWW.POLIGON.COM	
				by PORTER CORP		MAIN: (616) 888-3500	
						FIELD SUPPORT: (616) 888-3504	


**poligon**<sup>®</sup>



FRAME COLOR: **STREAK BLUE**  
ROOF COLOR: **CHARCOAL**  
COLORS MAY VARY SLIGHTLY FROM RENDERED IMAGE

COLLEGE PARK  
LOMOC, CA  
WALKWAY 8X31

**poligon**<sup>®</sup>

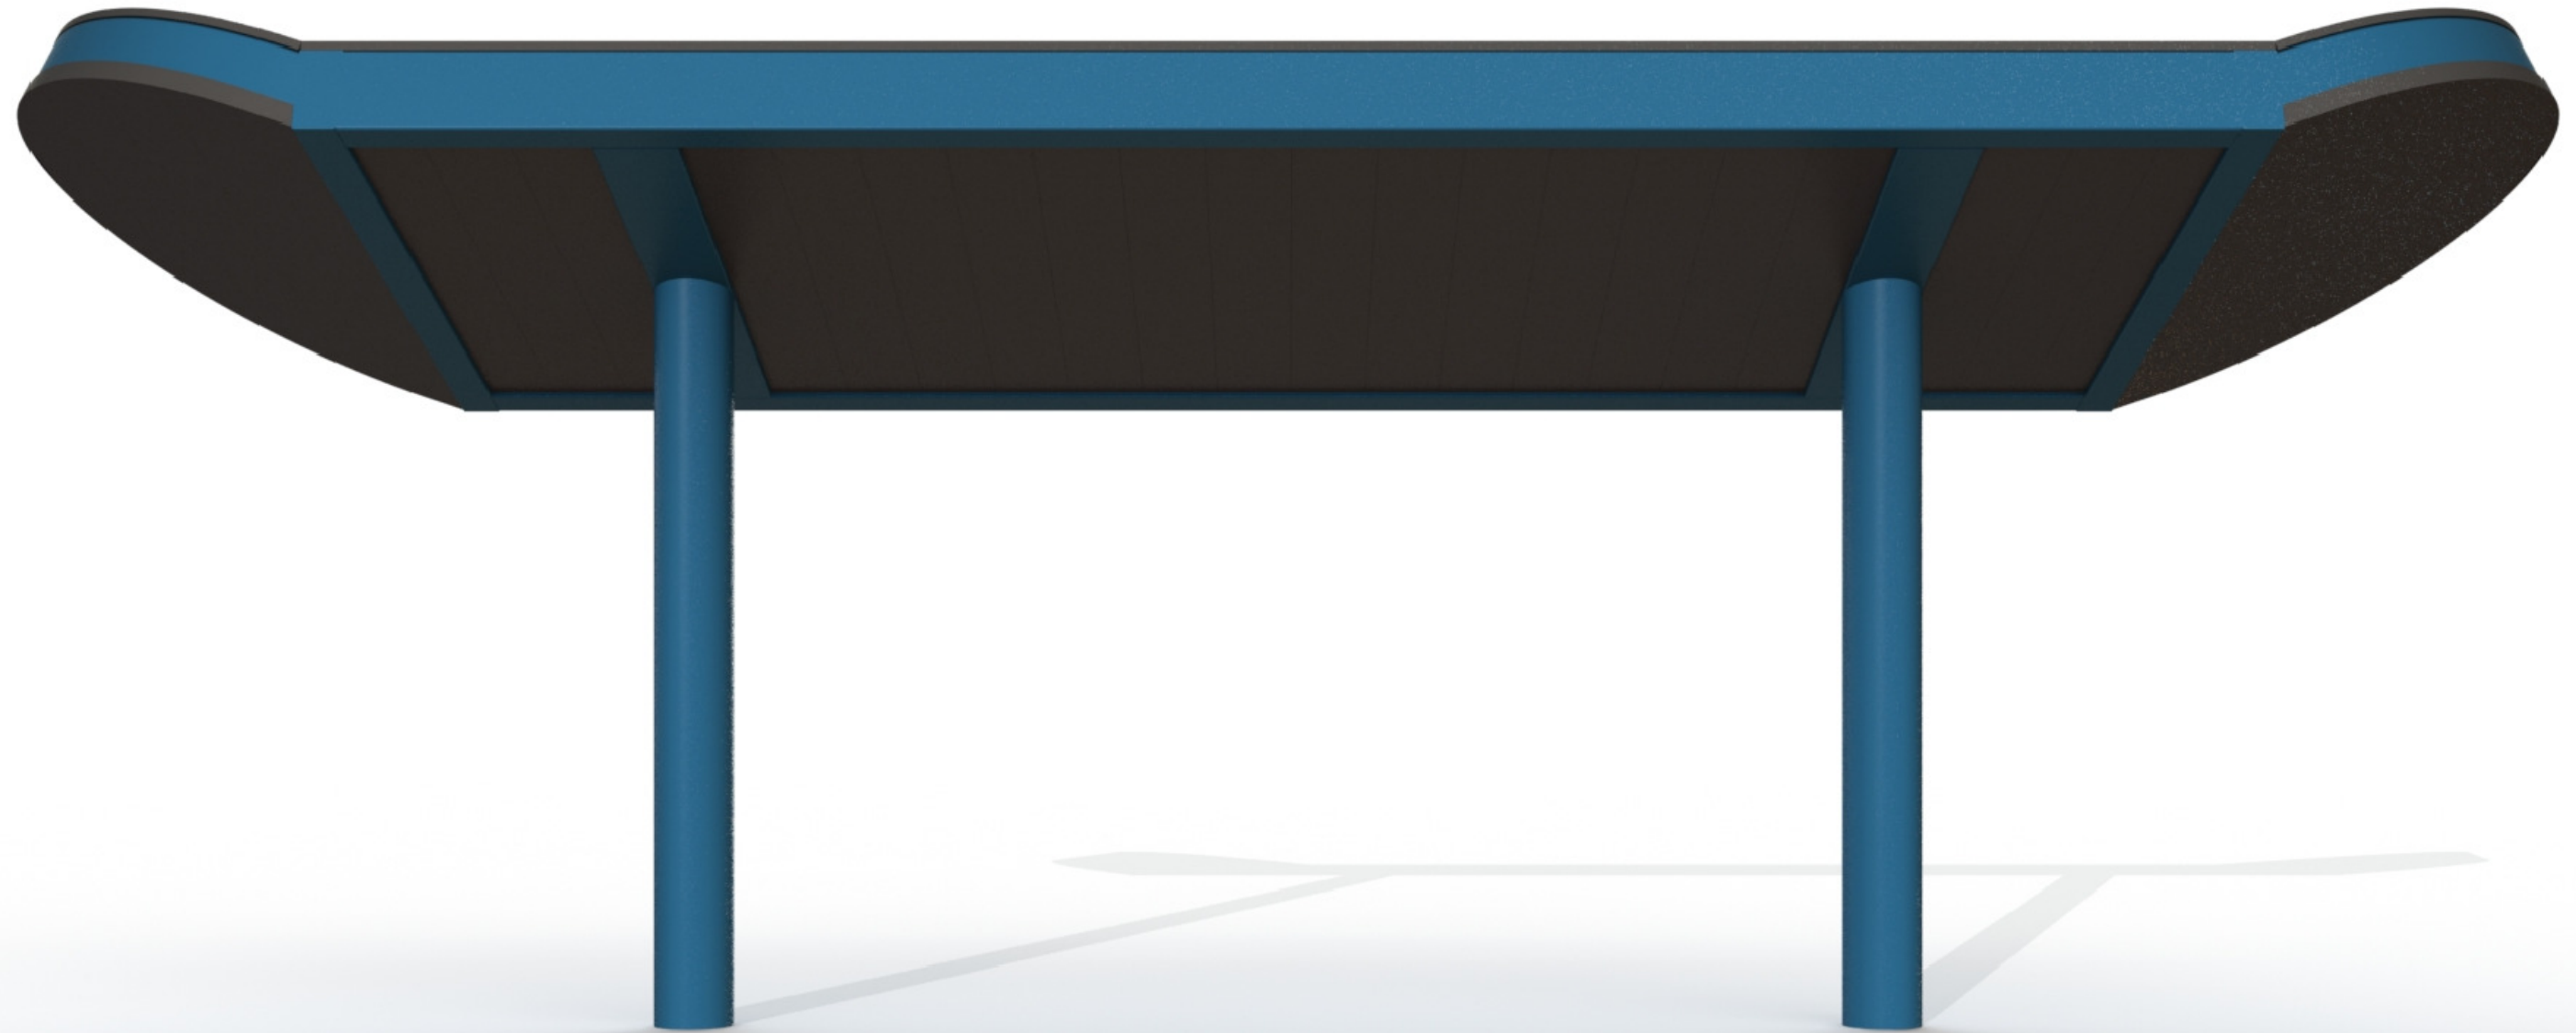

FRAME COLOR: **STREAK BLUE**  
ROOF COLOR: **CHARCOAL**  
COLORS MAY VARY SLIGHTLY FROM RENDERED IMAGE

COLLEGE PARK  
LOMOC, CA  
WALKWAY 8X31